

3

Planning Commission Study Session

TO: PLANNING COMMISSION / DESIGN REVIEW BOARD

FROM: ASHLEE MACDONALD, AICP, SENIOR PLANNER

(480) 503-6748, ASHLEE.MACDONALD@GILBERTAZ.GOV

THROUGH: CATHERINE LORBEER, AICP, PRINCIPAL PLANNER

(480) 503-6016, CATHERINE.LORBEER@GILBERTAZ.GOV

MEETING DATE: FEBRUARY 5, 2020

SUBJECT: DR19-193, Higley Self Storage

STRATEGIC INITIATIVE: Exceptional Built Environment

This project will allow for the development of a vacant property that will provide a commercial service to the community.

REQUEST

DR19-193, Higley Self Storage: Site plan, landscape, grading and drainage, elevations, floor plans, lighting, colors and materials, for approximately 2.16 acres, located at 1161 S. Higley Road, and zoned Maricopa County C-2.

RECOMMENDED MOTION

Request for input only. No motion required.

<u>APPLICANT</u> <u>OWNER</u>

Company: Great States Construction, Inc Company: AZ ES 1, LLC

Name: Michael Casper

Address: 1318 25th Ave South Address: 222 Broadway North

Fargo, North Dakota Fargo, North Dakota

Phone: 701-205-4717 Phone: 701-232-4423

Email: Michael@greatstates.us Email: aa@abernathyholdingco.com

BACKGROUND/DISCUSSION

Overview

The proposed project consists of a self-storage facility to be constructed on a 2.16 acre site. In conjunction with this design review application, the applicant has submitted an annexation application that is currently under review. The site is zoned Maricopa County - Intermediate Commercial (C-2); however if annexed, the subject site would be rezoned to the most comparable zoning district of Regional Commercial (RC) upon adoption of the annexation ordinance. The proposed self-storage facility includes a 96,470 square foot (sf), three-story building oriented towards Higley Road.

The site is accessed via a shared access on the northern boundary of the site off of Higley Road. Access into the site at this location would be right-in, right-out only.

Surrounding Land Use & Zoning Designations:

	Existing Land Use	Existing Zoning	Existing Use
	Classification		
North	Regional Commercial	Regional Commercial	Vacant
South	Regional Commercial	Maricopa County C-2	Vacant
East	Business Park	Business Park	Vacant
West	Business Park	Business Park	Higley Road, then School
Site	Regional Commercial	Maricopa County C-2	Vacant

Project Data Table

Site Development Regulations	Required per LDC	Proposed
Maximum Building Height (ft.)	55	41'-8"
Minimum Building Setback (ft.)		
Front	25	25
Side (Non-residential)	20	20
Rear (Non-residential)	20	20
Minimum Required Perimeter		
Landscape Area (ft.)		
Front	25	25
Side (Non-residential)	20	20
Rear (Non-residential)	20	20
Landscaping (% of net lot area)	15%	35%
Off-Street Parking and Loading	8 Spaces	8 spaces

DISCUSSION

Site

The site consists of one building containing the self-storage areas, parking and a loading area. The building itself is three-stories and approximately 96,740 sf. The property is located just north of the Santan Freeway, on the east side of Higley Road. A single access point is proposed at the north boundary of the site and will be shared access with the property to the north. Staff is working with the applicant to provide documentation that the property to the north is agreeable to this configuration. Additionally, the applicant has proposed a reciprocal access easement to serve as an emergency access on the property to the north. Documentation from the property owner to the north for this is also being sought.

The project is currently in second review and therefore additional comments, beyond what are included in this report, may be brought forward for discussion during the study session meeting.

Landscape

The onsite landscaping is proposed to exceed the minimum requirement with 35% site landscaping. The property is located within the Gateway Character area; specific landscaping is addressed in the Gateway Design Guidelines including the use of Pistache trees, which are included along the Higley Road street frontage. The applicant has also provided foundation landscaping along the north and south sides of the building. Additional plantings are consistent with the recommended plant list for the Gateway Character area and include Yellow Bells, Mexican Honeysuckle, Rio Bravo Sage and petite Pink Oleanders, among others.

Grading and Drainage

Drainage is provided through two primary retention basins on the east and west portions of the site.

Elevations, Floor Plan, Colors and Materials

The site is located within the Gateway Character area; the design guidelines for this area emphasize a traditional design approach, reminiscent of the heritage of Gilbert. The design of the proposed facility includes a red brick along the first floor. The second and third floors are primarily comprised of EIFS (Amarillo White and Gray Steele). Metal paneling is also provided around the building to break up the massing and provide some vertical articulation. The westernmost portion and the southeast corner of the building include large windows with roll-up storage doors set back from the windows, as is often seen with storage facility buildings.

The applicant has proposed metal screening around the mechanical units; staff is seeking Commission input on the screening of these units and whether or not the screening is well integrated. As a reminder, the Land Development Code (LDC) Section 4.105 (B.)(1.)(c.) specifies, "Roof-mounted mechanical equipment shall be fully screened by a parapet wall or other building elements equal to or exceeding the height of the mechanical units. These building elements shall be an integral part of the building design"

Lighting

There are four lighting types proposed including parking lot, wall mounted and two types of canopy mounted fixtures. All site lighting will be required to comply with Town codes.

PUBLIC NOTIFICATION AND INPUT

The proposed project will require public notice as specified under Land Development Code (LDC) Section 5.602.A.3.

REQUESTED INPUT


- 1. Overall architecture consistency with Gateway Character area and traditional design
- 2. Mechanical screening

Respectfully submitted,


Ashlee MacDonald, AICP Senior Planner

Attachments and Enclosures:

- 1) Aerial Photo
- 2) Site Plan
- 3) Landscape
- 4) Grading and Drainage
- 5) Colors and Materials
- 6) Elevations
- 7) Floor Plans
- 8) Lighting

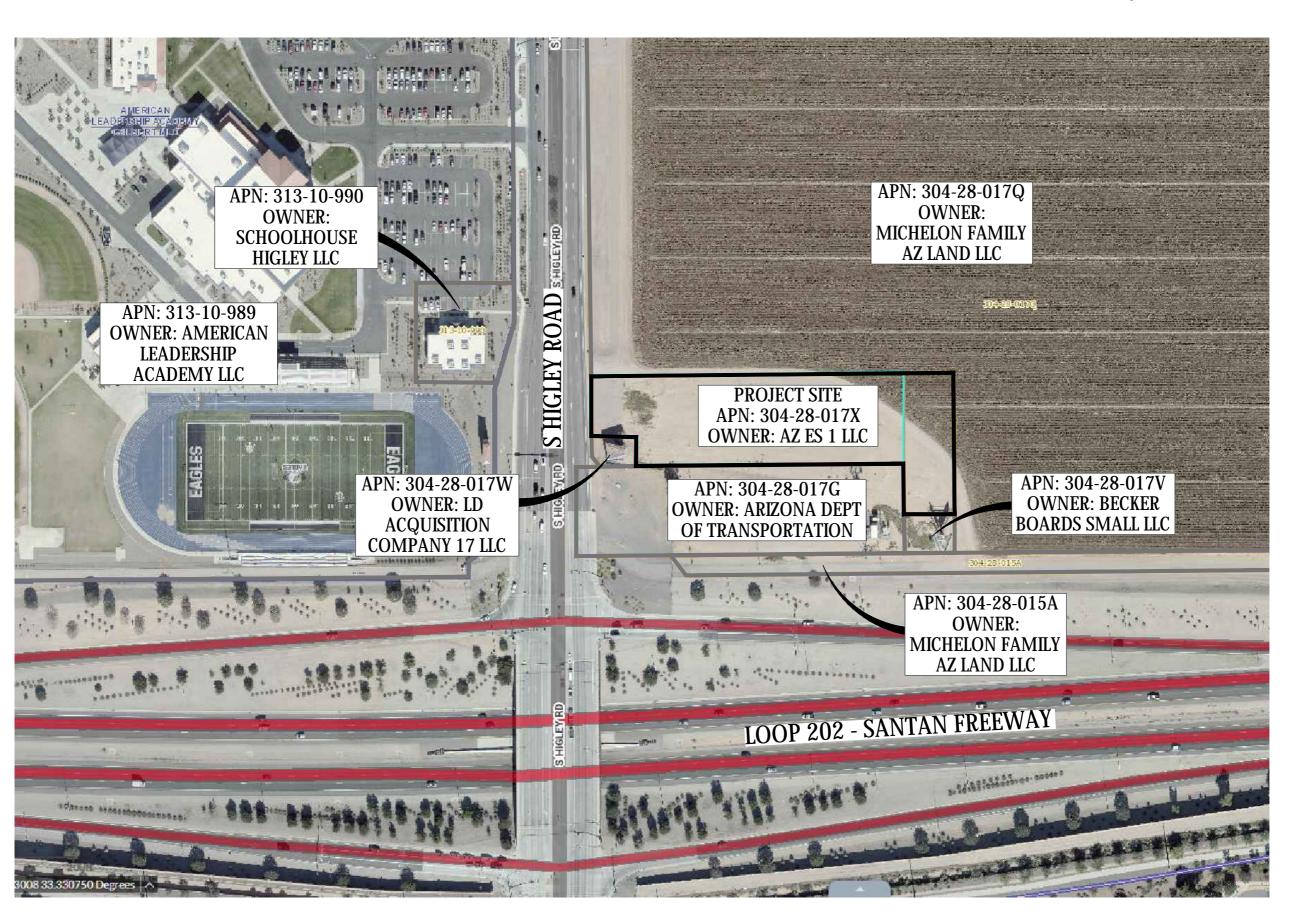



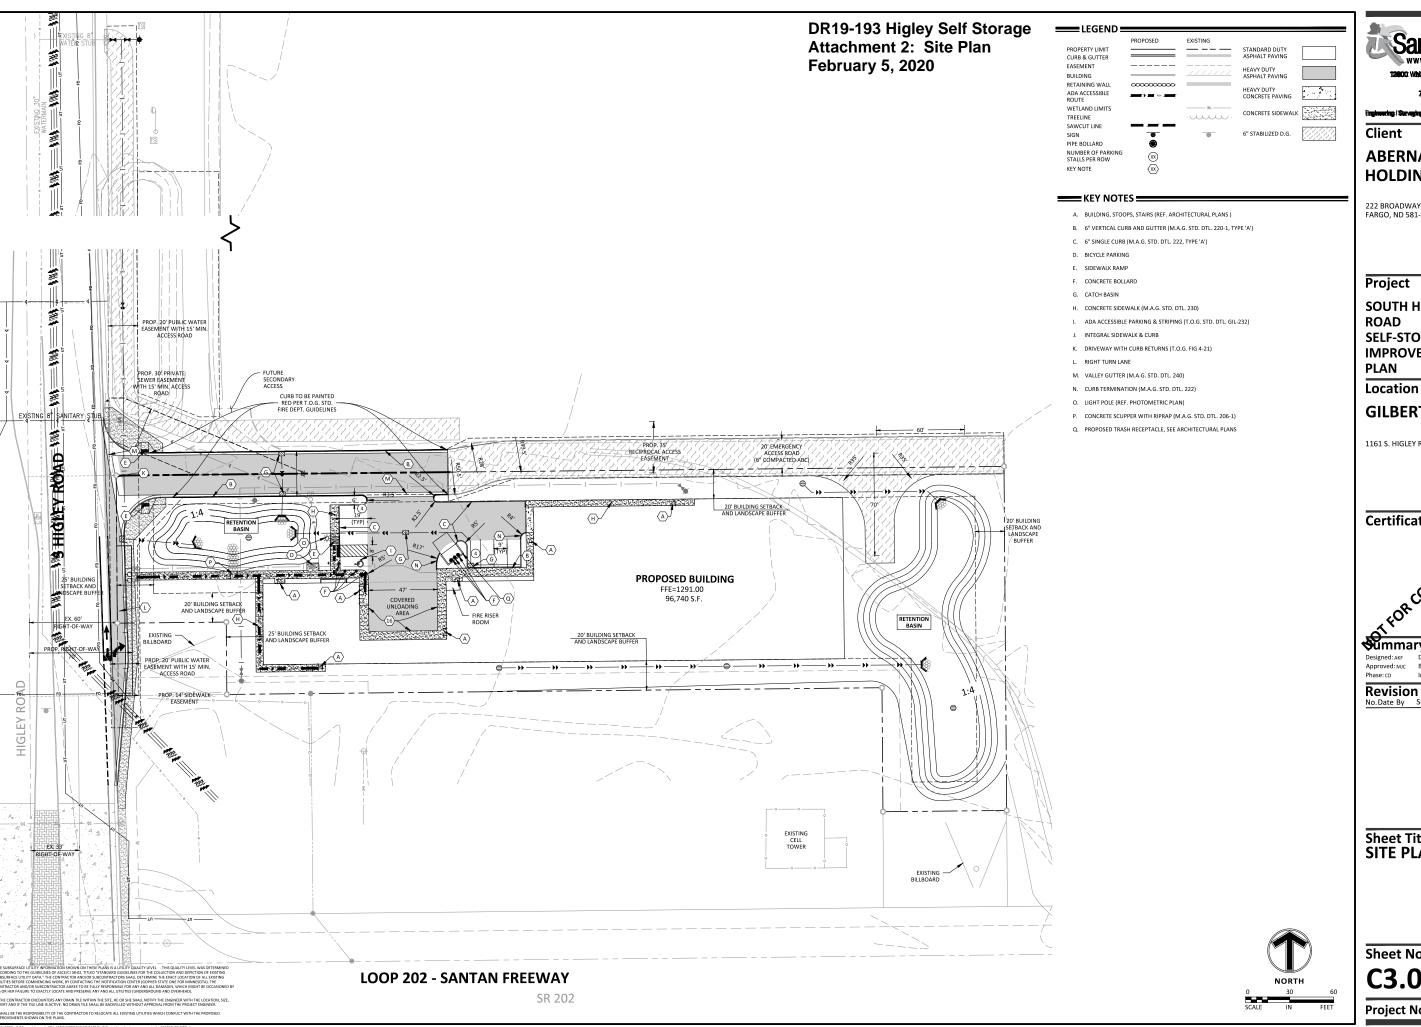



Client

ABERNATHY HOLDING CO.

222 BROADWAY N., SUITE B101 FARGO, ND 581-2

Project

SOUTH HIGLEY ROAD **SELF-STORAGE IMPROVEMENT** PLAN

GILBERT, AZ

1161 S. HIGLEY RD 85296


Designed: AKF Drawn: AKF Approved: MJC Book / Page: Initial Issued: 12/06/2019

Revision History No.Date By Submittal / Revi

Sheet Title SITE PLAN

Sheet No. Revision C3.0

Project No. 21812

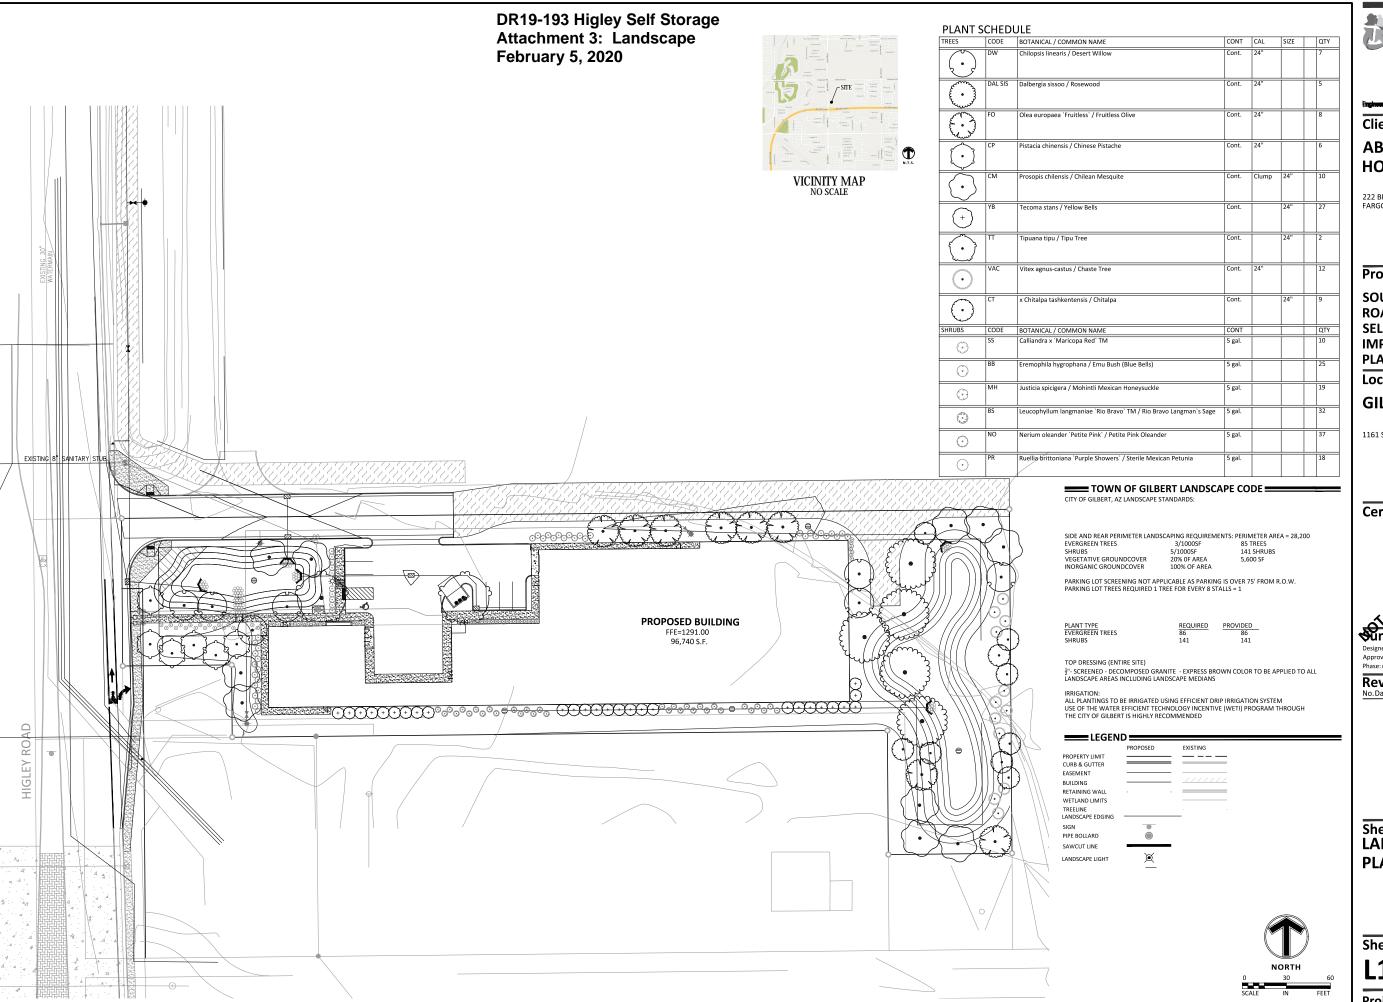

Client

ABERNATHY HOLDING CO.

222 BROADWAY N., SUITE B101 FARGO, ND 581-2

Project **SOUTH HIGLEY** ROAD **SELF-STORAGE IMPROVEMENT** PLAN Location

GILBERT, AZ

1161 S. HIGLEY RD 85296


Designed: AKF
Approved: MIC
Approved: MIC
Initial Issued: 12/06/2019

Revision History
No. Date By Submittal / Revision

Sheet Title LANDSCAPE **PLAN**

Sheet No. Revision L1.0

Project No. 21812

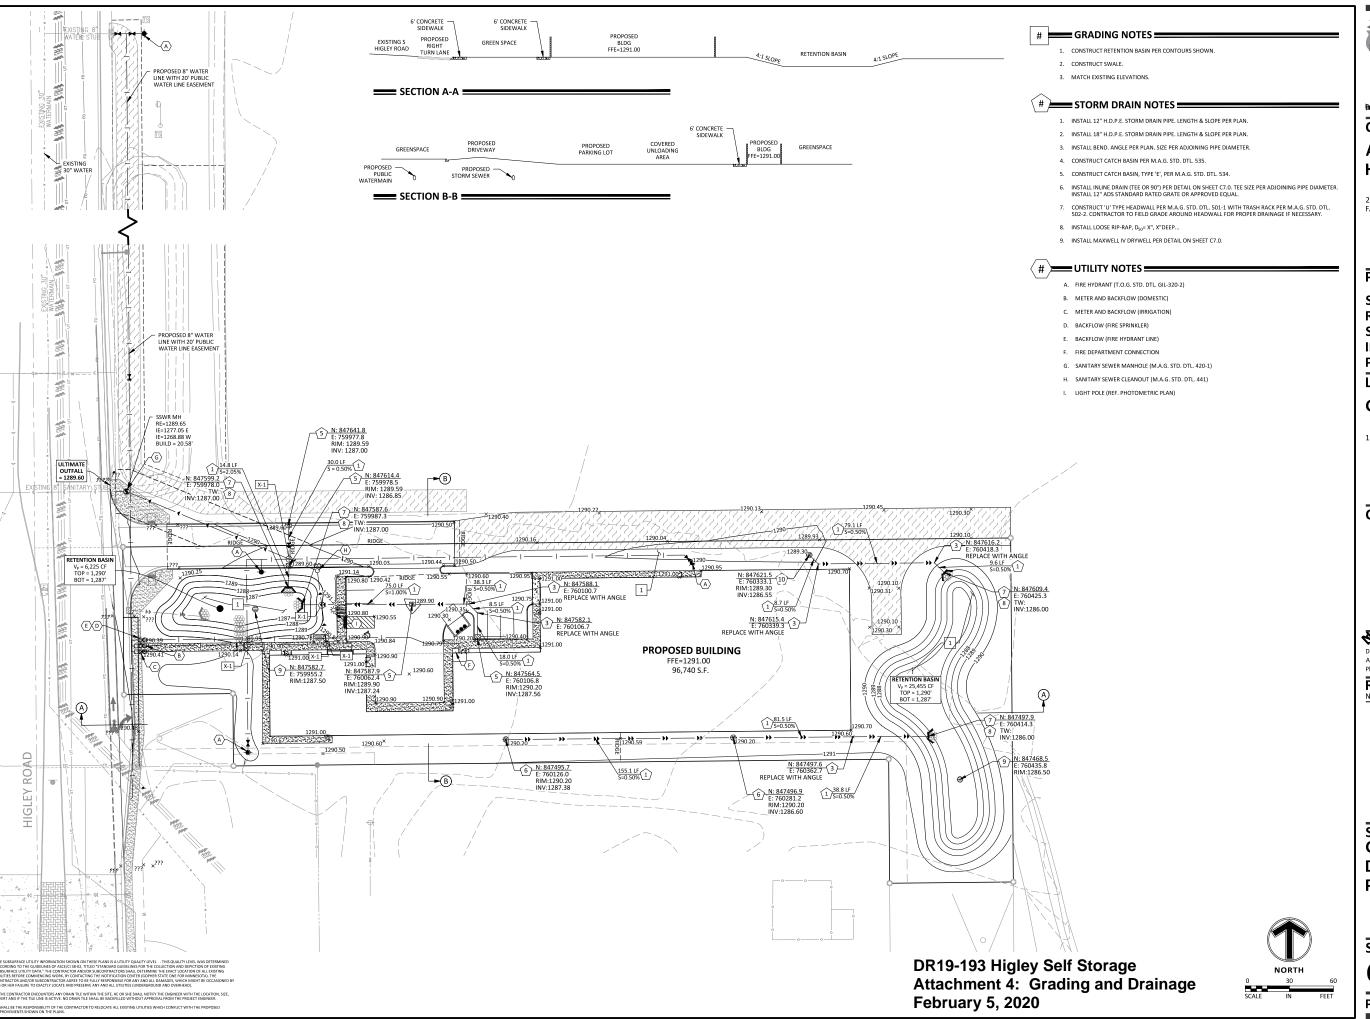

Client

ABERNATHY HOLDING CO.

222 BROADWAY N., SUITE B101 FARGO, ND 581-2

Project

SOUTH HIGLEY ROAD **SELF-STORAGE IMPROVEMENT PLAN**

Location

GILBERT, AZ

1161 S. HIGLEY RD 85296

Certification

Designed: AKF DrayProved: MIC P

Initial Issued: 12/06/2019

Revision History No.Date By Submittal / Revi

Sheet Title GRADING & DRAINAGE PLAN

Sheet No. Revision

C5.0

Project No. 21812

DR19-193 Higley Self Storage Attachment 5: Colors and Materials February 5, 2020









EXTERIOR MATERIALS LEGEND EIFS. DEXTERIOR INSULATION AND FINISH SYSTEM - DRYVIT OUTSULATION COLOR: AMARILLO WHITE TEXTURE; SANDPEBBLE FINE-NTX

EXTERIOR INSULATION AND FINISH SYSTEM COLOR: GRAY STEELE TEXTURE: SANDPEBBLE FINE-NTX MODULAR THIN BRICK - METROBRICK COLOR: SCHOOLHOUSE RED

ACM PANEL & PREFINISHED METAL TRIM
COLOR: DARK GREY TO MATCH SHERWIN WILL EXTERIOR PAINT COLOR: SHERWIN WILLIAMS IRON ORE

8 8300


7 TRASH ENCLOSURE PLAN
A300) 1/4" = 1'-0"



SOUTH ELEVATION - OVERALL
(A300) 1/16" = 1'-0"



8300 1/16" = 1"-0"

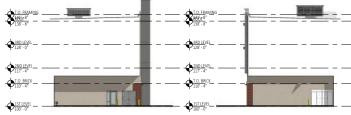

5 DRIVE-UNDER WEST ELEVATION
(a) DRIVE-UNDER EAST ELEVATION
(A) DRIVE-UNDER EAST ELEVATION
(A) DRIVE-UNDER EAST ELEVATION



NORTH ELEVATION - OVERALL
A300) 1/16" - 1'-0"



MTL-1: ALMOND MTL-2: LIGHT GREY TRIM/FEATURES TRIM/FEATURES



ACM PANELS -ZINC PATINA

MTL-4: LIGHT GREY 7.2 PROFILE METAL PANEL



P-1: DARK GREY EXTERIOR PAINT -ALUMINUM STOREFRONT SHERWIN WILLIAMS IRON ORE AND GLASS

TRASH ENCLOSURE ELEVATION
A300) 1/4" = 1'-0"



RECESSES FOR GATE CANE BOLTS. PROVIDE TWO EACH AT GATE IN CLOSED AND OPEN POSITION, FIELD VERIFY EXACT LOCATION

RECEIVING SLEEVE FOR 1/4" BOLT W/ 5/16" INSIDE DIAM.-3" LONG (GALV.)

GREAT STATES SOUTH HIGLEY ROAD SELF-STORAGE NEW CONSTRUCTION

13244 S. HIGLEY RD GILBERT, AZ 85296



Tel 952-426-7400



80% PRICING REVIEW	11/1/2019
PERMIT DOCUMENTS	12/30/2019
2.4.74	
· ·	
	_
	_
	-
_	
_	
_	
	_
	_


EXTERIOR BUILDING ELEVATIONS

PERMIT DOCUMENTS


A300





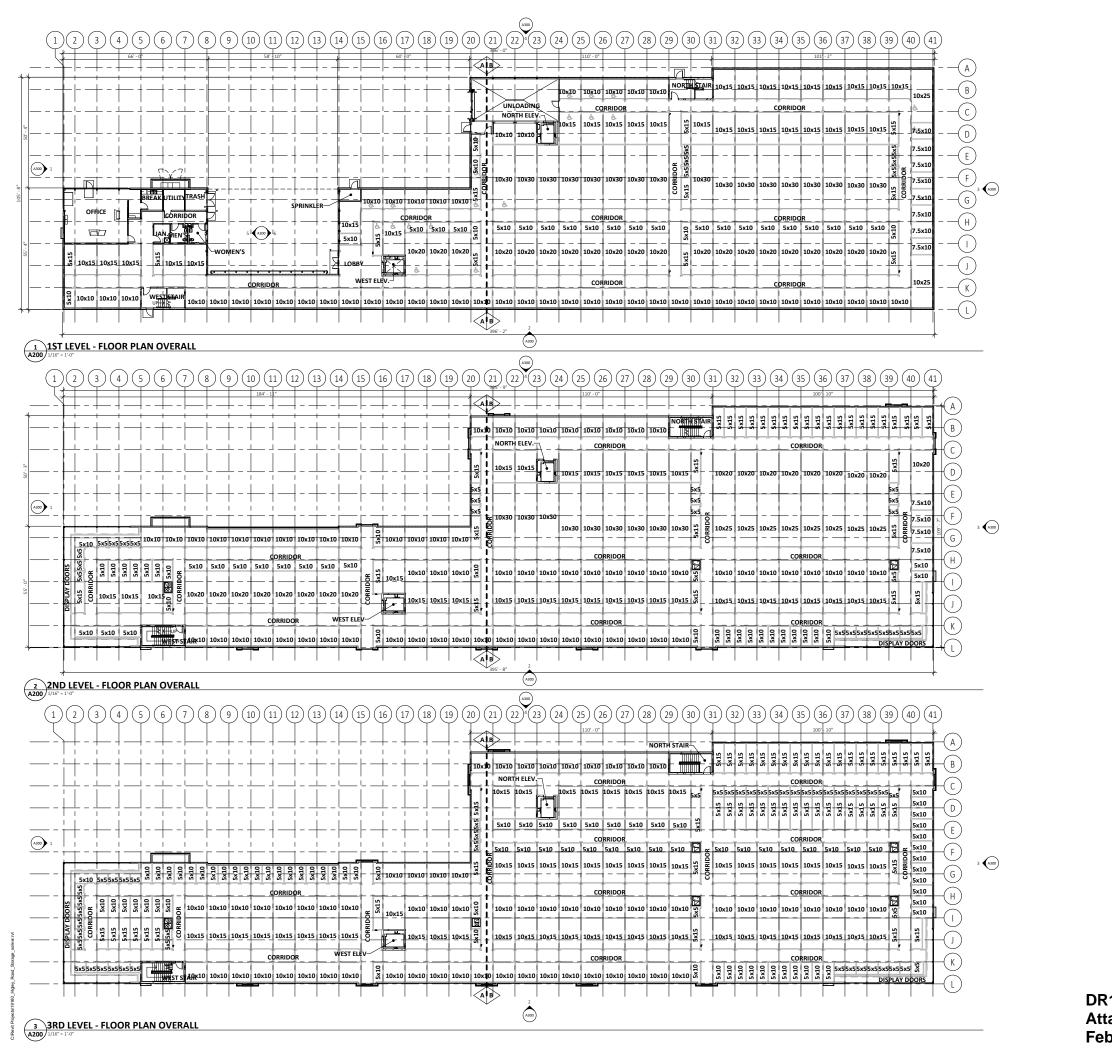

		T MIX - OVE			A 10
UNIT SIZE 5x5 5x10	81 146	Unit Type Percentage 11.6% 20.9%	UNIT CLASS S.F. 25 50	UNIT CLASS TOTAL AREA 2025 7300	GREAT STATES CONSTRUCTION
5x15 7.5x10	95 12	13.6%	75 75	7125 900	
10x10 10x15	176 116	25.2% 16.6%	100 150	17510 17400	SOUTH HIGLEY ROAD
10x20	37	5.3%	200	7400	SELF-STORAGE
10x25 10x30	10 26	1.4% 3.7%	250 300	2500 7800	NEW CONSTRUCTION
Grand total	699			69960	
UNIT SIZE		T MIX - 1ST Unit Type Percentage		S.F. UNIT CLASS TOTAL AREA	
5x5 5x10	6 27	3.6%	25	150 1350	
5x15	11	6.5%	75	825	
7.5x10 10x10	8 48	4.7% 28.4%	75 100	600 4800	13244 S. HIGLEY RD
10x15 10x20	30 20	17.8% 11.8%	150 200	4500 4000	GILBERT, AZ 85296
10x25 10x30	2 17	1.2% 10.1%	250 300	500 5100	
Grand total	169			21825	ш
		MIX - 2ND			РРОЈЕСТ МАМЕ
UNIT SIZE 5x5	COUNT 26	Unit Type Percentage 11.3%	UNIT CLASS S.F.	UNIT CLASS TOTAL AREA 650	PROJE
5x10 5x15	37 32	16.1% 13.9%	50 75	1850 2400	
7.5x10 10x10	4 65	1.7% 28.3%	75 100	300 6410	
10x15 10x20	32 17	13.9% 7.4%	150 200	4800 3400	
10x25 10x30	8 9	3.5% 3.9%	250 250 300	2000 2700	
Grand total	230	3.370	300	24510	
	UNIT	ΓMIX - 3RD	LEVEL W	S.F.	
UNIT SIZE	COUNT	Unit Type Percentage	UNIT CLASS S.F.	UNIT CLASS TOTAL AREA	
5x5 5x10 5x15	49 82 52	16.3% 27.3% 17.3%	25 50 75	1225 4100 3900	
10x10	63	21.0%	100	6300	
10x15 Grand total	54 300	18.0%	150	8100 23625	
					THE ARCHITECT SHALL BE DEEMED THE AUTHORS AND OWNERS OF THEIR RESPECTIVE INSTRUMENTS OF SERVICE OWNERS OF SERVICE OWNERS OF THEIR RESPECTIVE INSTRUMENTS OF THE ATTACHED OCCUMENTS OD OSSIGNATION OF THE AUTHORS OF THE AUTHORS AND OWNERS OF THEIR RESPECTIVE DRIVEN OF SERVICE OWNERS OF SERVICE OWNERS OF THE AUTHORS OF SERVICE OWNERS OF THE AUTHORS AND OWNERS OF SERVICE OWNERS OF SERVICE OWNERS OF THE AUTHORS AND OWNERS OF SERVICE OWNERS OF SERVICE OWNERS OF SERVICE OWNERS OF SERVICE OWNERS OF THE AUTHORS AND OWNERS OF SERVICE OWNERS OWNERS OWNERS OWNERS OWNERS OF SERVICE OWNERS OWNE
					PROJECT NAMBER: 1910 (MAR DIAM'N BY: N. MISSING OHECKED BY: S. CLIVER DATE 12-30-2019 FLOOR PLANS - OVERALL
	ent	igley S 7: Floo 2020			PERMIT DOCUMENTS A200

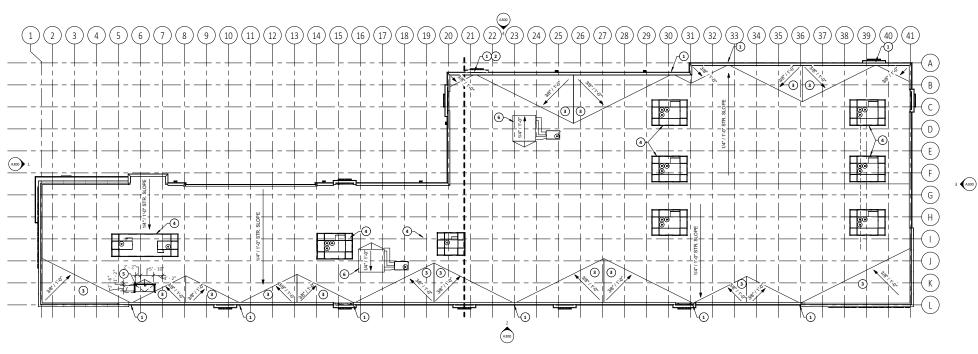

1 ROOF PLAN 1/16" = 1'-0"

GENERAL ROOF NOTES

ROOF PLAN KEYNOTES

IAG	KETNUTE
1	SCUPPER/OVERFLOW TO DOWNSPOUT
2	COORDINATE OUTLET WITH CIVIL - AVOID SURFACE DRAINAGE OVER SIDEWALK.

GREAT STATES

SOUTH HIGLEY ROAD SELF-STORAGE NEW CONSTRUCTION

13244 S. HIGLEY RD GILBERT, AZ 85296



Tel 952-426-7400 Fax 952-426-7440

NO.	DESCRIPTION	DATE
	80% PRICING REVIEW	11/1/2019
	PERMIT DOCUMENTS	12/30/2019

12-30-2019

ROOF PLAN AND ROOF DETAILS

PERMIT DOCUMENTS



A204



L-Grid®2EH 1x1

Soffit Luminaire Series

For applications in welloways, overhangs, canoples, bathrooms, or confined spaces, US LED offers the L-Grid@ZEH 1xt. The L-Grid@ZEH 1xt is an attractive and low-profile soffits colution that will blend in with the surrounding area while delivering an exceptional quality of light. And installation is simple and straight-forward, regardless of the explication.

Features

Peatures

- Phenomenal light output while only using 23.5 Watts

- Class 2 compliant design (low voltage, limited power)

- 0-10V Dimmable via Mark VII (requires the
DCA-10-120 Dimming Controller)

- Production of the Controller of CRE (200 hours)

Specifications	

Spec Type	Data
Dimensions	12.1" x 12.1" x 3.2"
Units/Carton	1
Net Weight	6 lbs.
Environmental Rating	Damp

Energy Data			
Spec Type	3500K	4000K	5000K
Input Voltage (VAC)	120-277	120-277	120-277
System Level Power (W)	23.5	23.5	23.5
Delivered Lumens (Lm)	2,260	2,230	2,250
System Efficacy (Lm/W)	96	95	96
Color Rendering Index (CRI)	80 min	80 min	80 min
L70 Calcualted Life (Hrs.)1	200,000	200,000	200,000
L85 Calcualted Life (Hrs.)1	129,000	129,000	129,000

Operating Temperature (°C) -30 to 45 -30 to 45 -30 to 45

- UL 1598 Listed (E344008) - DesignLights Consortium Li - LM-79 available

CUL US (III)







EcoNight® 3

Full Cut-off LED Wall Pack Luminaire For exterior well lighting in new or retroff construction, with tight specification requirements, US LED offers the EcoNight® 3. The Dark Sky compliant EcoNight® 3 wall pack addresses all of the exterior prerequisites by offering stellar light output, ease of implementation, and significant decreases to maintenance costs. The EcoNight® 3 has a familiar footprint to existing metal halide wall pack fatures, ensuring that installation in new construction or retrofit projects will be simple.

Features
- Low voltage Class 2 design
- Uses up to 80% less power than equivalent metal hailde
- Full cut-off design
- Ton-year warranty

Certifications - Intertek (ETL 400659 - DLC Premium Listed Intertek

рес Туре	Data
Dimensions	14.22" x 9.12" x 12.0"
Inits/Carton	1
let Weight	9.35 lbs.
nvironmental Rating	Wet

Spec Type	30W	40W
Input Voltage (VAC)	120-277	120-277
System Level Power (W)	30	40
Delivered Lumens (Lm)	4,480	5,720
Efficacy (Lm/W)	149	143
Color Temperature (K)	3000 4000 5000	3000 4000 5000
Color Rendering Index (CRI)	70 min	70 min
:	146,000	146,000
:	67,000	67,000
Operating Temperature (° C)	-40 to 40	-40 to 40

Series	Variant	Voltage	CCT	Drive Current	Fixture Color
DSCO1	3				



FIXTURE TYPE S3



			Mounting			
24 VDC			Mounting	4' (1.2 m)		
4' (1.2 m) 1' (0.3 m)				1' (0.3 m)	Wire nut hou Mounting cli Wire nut hou	ps (2 ind.),
5000 K			Documentation			
3500 K	93 lm/W		Warranty	5-year lin	rited	
	5000 K	3500 K	Agency listings		N&I 2, ETL, CE, hts Consortium" (DLC), F	oHS
4' (1.2 m) 1' (0.3 m)			Files available			
Linear). 🕎 zu 117 3	II) C €	RoHS Compliant	
5000 K, 3500 K			5000 Konly		SIOO K only	
5000 K 3500 K			Accessories			
IP66 & IP68 ⁴ Dry, damp, and we	et locations			6	A	B
-25°C to 50°C			-40			
100,000 hours (L ₂₂	p		Mounting Clip		Wire Nut Housing	
Optional Motion S (see Cold Series Di		data sheet)	Three (3) included with 4 ft (1 Two (2) included with 1 ft (0.3		Two (2) included with 4 Two (2) included with 1	




(3)

TV / SECURITY CAMERA - PTZ - PAN, TILT, ZOOM (MOUNTING PER PLANS)



ELECTRICAL SYMBOL LIST

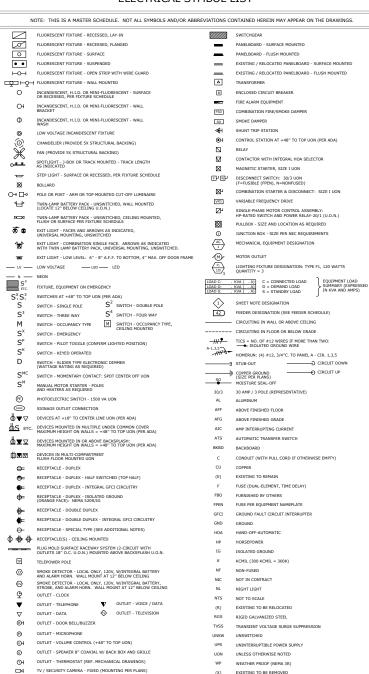

	DRAWING INDEX					
SHEET NUMBER	SHEET TITLE	CITY SUBMITTAL - DESIGN REVIEW DATE: 11.01.2019	***	***	***	
E001	ELECTRICAL SYMBOLS LIST AND CUT-SHEETS	•				
E100	PHOTOMETRIC SITE PLAN	•				ĺ
						Ī
	TOTAL					Ī

DR19-193 Higley Self Storage Attachment 8: Lighting February 5, 2020

GREAT STATES

SOUTH HIGLEY ROAD SELF-STORAGE **NEW CONSTRUCTION**

13244 S. HIGLEY RD GILBERT, AZ 85296

msa





THE ARCHITECT SHALL BE DEEMED THE ALITHORS A


11,01,2019

ELECTRICAL SYMBOLS LIST AND

CITY SUBMITTAL - DESIGN REVIEW

CUT-SHEETS

E001

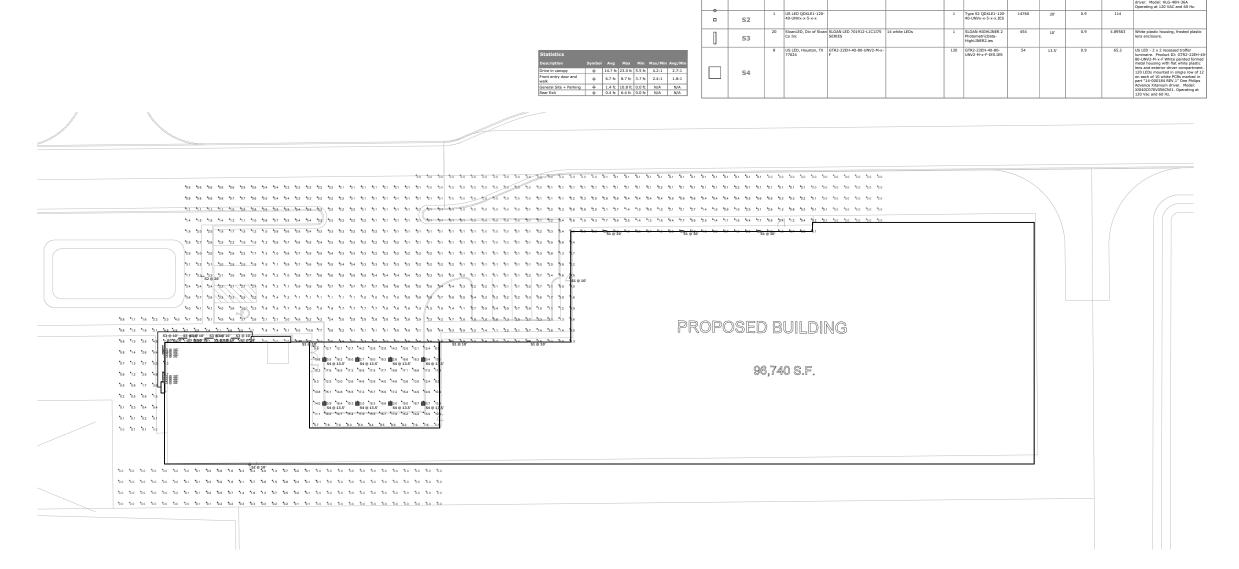

PHOTOMETRIC SITE PLAN

E100 1/16" = 1'-0"

S1

	GREAT STATES CONSTRUCTION
	SOUTH HIGLEY ROAD SELF-STORAGE NEW CONSTRUCTION
	13244 S. HIGLEY RD GILBERT, AZ 85296
PROJECT NAME	
	ENGINEERING CONSULTANTS 7979 Property, AZ 5020 602-943-8424 MAS-8-419120
ARCHITECT	1000 Twelve Oaks Center Dr. Suite 200 Weyzeta MM 55391 Tel 982-426-7400 Fax 982-426-7440
REGISTRATION	JUSTIN C. DA GERMAN DE COMPANY DE
	COPYRIGHTS OF THE ATTACHED DOCUMENTS. NO. DESCRIPTION DATE
ORD	
ISSUE RECORD	
-	
7	PROJECT NUMBER: 19160,0ABR
ORMATIO	DRAWN BY: MSA CHECKED BY: PE
DRAWING INFORMATION	DATE: 11.01.2019
DRA	COMPUTER DIRECTORY: F:PRJ/19/A19120/CADIELEC/A19120-E100_DR.dwg
SHEET DESCRIPTION	PHOTOMETRIC SITE PLAN
PHASE	CITY SUBMITTAL - DESIGN REVIEW
	N
	E100